

## Planning Commission Study Session

**TO:** PLANNING COMMISSION / DESIGN REVIEW BOARD

**FROM:** ASHLEE MACDONALD, AICP, SENIOR PLANNER *Am*  
(480) 503-6748, ASHLEE.MACDONALD@GILBERTAZ.GOV

**THROUGH:** CATHERINE LORBEER, AICP, PRINCIPAL PLANNER *ajl*  
(480) 503-6016, CATHERINE.LORBEER@GILBERTAZ.GOV

**MEETING DATE:** FEBRUARY 5, 2020

**SUBJECT:** DR19-193, Higley Self Storage

**STRATEGIC INITIATIVE:** Exceptional Built Environment

This project will allow for the development of a vacant property that will provide a commercial service to the community.

### **REQUEST**

DR19-193, Higley Self Storage: Site plan, landscape, grading and drainage, elevations, floor plans, lighting, colors and materials, for approximately 2.16 acres, located at 1161 S. Higley Road, and zoned Maricopa County C-2.

### **RECOMMENDED MOTION**

Request for input only. No motion required.

**APPLICANT**

Company: Great States Construction, Inc  
 Name: Michael Casper  
 Address: 1318 25<sup>th</sup> Ave South  
 Fargo, North Dakota  
 Phone: 701-205-4717  
 Email: Michael@greatstates.us

**OWNER**

Company: AZ ES 1, LLC  
 Address: 222 Broadway North  
 Fargo, North Dakota  
 Phone: 701-232-4423  
 Email: aa@abernathyholdingco.com

**BACKGROUND/DISCUSSION****Overview**

The proposed project consists of a self-storage facility to be constructed on a 2.16 acre site. In conjunction with this design review application, the applicant has submitted an annexation application that is currently under review. The site is zoned Maricopa County - Intermediate Commercial (C-2); however if annexed, the subject site would be rezoned to the most comparable zoning district of Regional Commercial (RC) upon adoption of the annexation ordinance. The proposed self-storage facility includes a 96,470 square foot (sf), three-story building oriented towards Higley Road.

The site is accessed via a shared access on the northern boundary of the site off of Higley Road. Access into the site at this location would be right-in, right-out only.

**Surrounding Land Use & Zoning Designations:**

	<b>Existing Land Use Classification</b>	<b>Existing Zoning</b>	<b>Existing Use</b>
North	Regional Commercial	Regional Commercial	Vacant
South	Regional Commercial	Maricopa County C-2	Vacant
East	Business Park	Business Park	Vacant
West	Business Park	Business Park	Higley Road, then School
Site	Regional Commercial	Maricopa County C-2	Vacant

**Project Data Table**

<b>Site Development Regulations</b>	<b>Required per LDC</b>	<b>Proposed</b>
Maximum Building Height (ft.)	55	41'-8"
Minimum Building Setback (ft.)		
Front	25	25
Side (Non-residential)	20	20
Rear (Non-residential)	20	20
Minimum Required Perimeter Landscape Area (ft.)		
Front	25	25
Side (Non-residential)	20	20
Rear (Non-residential)	20	20
Landscaping (% of net lot area)	15%	35%
Off-Street Parking and Loading	8 Spaces	8 spaces

## **DISCUSSION**

### **Site**

The site consists of one building containing the self-storage areas, parking and a loading area. The building itself is three-stories and approximately 96,740 sf. The property is located just north of the Santan Freeway, on the east side of Higley Road. A single access point is proposed at the north boundary of the site and will be shared access with the property to the north. Staff is working with the applicant to provide documentation that the property to the north is agreeable to this configuration. Additionally, the applicant has proposed a reciprocal access easement to serve as an emergency access on the property to the north. Documentation from the property owner to the north for this is also being sought.

The project is currently in second review and therefore additional comments, beyond what are included in this report, may be brought forward for discussion during the study session meeting.

### **Landscape**

The onsite landscaping is proposed to exceed the minimum requirement with 35% site landscaping. The property is located within the Gateway Character area; specific landscaping is addressed in the Gateway Design Guidelines including the use of Pistache trees, which are included along the Higley Road street frontage. The applicant has also provided foundation landscaping along the north and south sides of the building. Additional plantings are consistent with the recommended plant list for the Gateway Character area and include Yellow Bells, Mexican Honeysuckle, Rio Bravo Sage and petite Pink Oleanders, among others.

### **Grading and Drainage**

Drainage is provided through two primary retention basins on the east and west portions of the site.

### **Elevations, Floor Plan, Colors and Materials**

The site is located within the Gateway Character area; the design guidelines for this area emphasize a traditional design approach, reminiscent of the heritage of Gilbert. The design of the proposed facility includes a red brick along the first floor. The second and third floors are primarily comprised of EIFS (Amarillo White and Gray Steele). Metal paneling is also provided around the building to break up the massing and provide some vertical articulation. The westernmost portion and the southeast corner of the building include large windows with roll-up storage doors set back from the windows, as is often seen with storage facility buildings.

The applicant has proposed metal screening around the mechanical units; staff is seeking Commission input on the screening of these units and whether or not the screening is well integrated. As a reminder, the Land Development Code (LDC) Section 4.105 (B.)(1.)(c.) specifies, “Roof-mounted mechanical equipment shall be fully screened by a parapet wall or other building elements equal to or exceeding the height of the mechanical units. These building elements shall be an integral part of the building design”

**Lighting**

There are four lighting types proposed including parking lot, wall mounted and two types of canopy mounted fixtures. All site lighting will be required to comply with Town codes.

**PUBLIC NOTIFICATION AND INPUT**

The proposed project will require public notice as specified under Land Development Code (LDC) Section 5.602.A.3.

**REQUESTED INPUT**

1. Overall architecture – consistency with Gateway Character area and traditional design
2. Mechanical screening


Respectfully submitted,

Ashlee MacDonald, AICP  
Senior Planner

**Attachments and Enclosures:**

- 1) Aerial Photo
- 2) Site Plan
- 3) Landscape
- 4) Grading and Drainage
- 5) Colors and Materials
- 6) Elevations
- 7) Floor Plans
- 8) Lighting

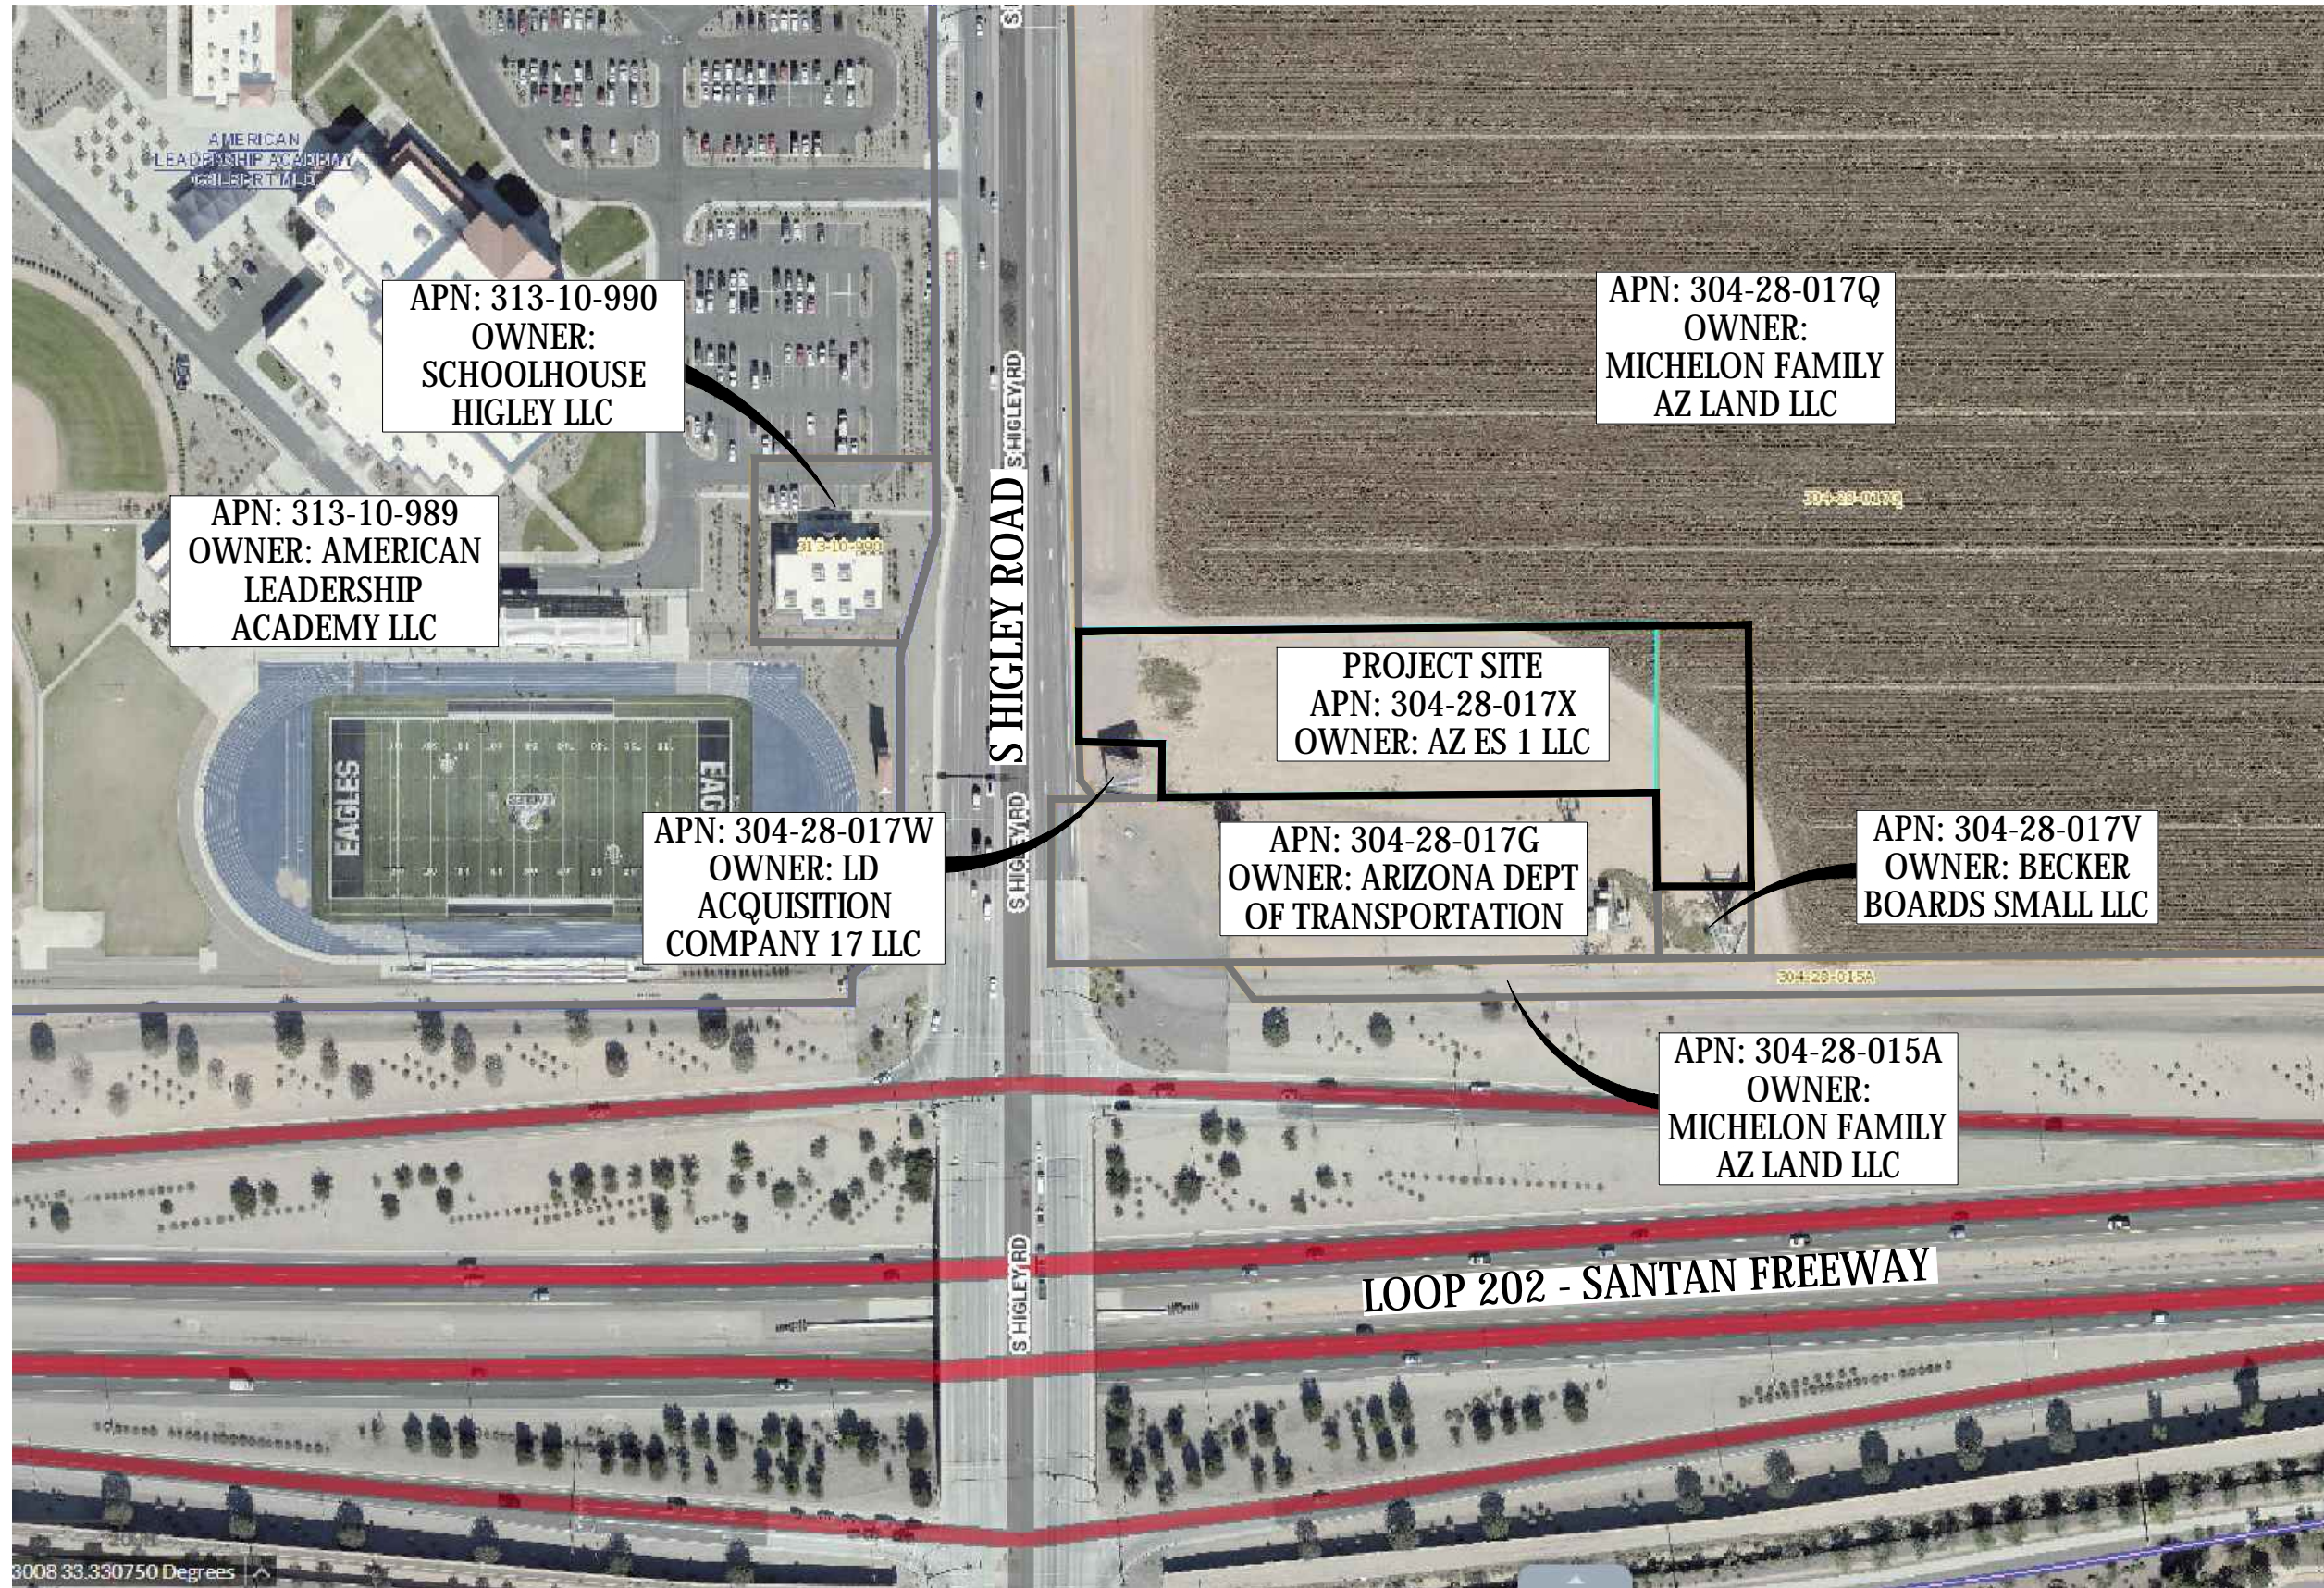

[illegible]

PROJECT NUMBER: 19160.0ABR

DRAWN BY: A. FELDBERG

CHECKED BY: M. CARON

DATE: 11-01-2019

COMPUTER DIRECTORY:

Path


PARCEL/AERIAL  
MAPCITY SUBMITTAL - DESIGN  
REVIEW



DR19-193 Higley Self Storage  
Attachment 2: Site Plan  
February 5, 2020

LEGEND			
PROPERTY LIMIT	PROPOSED	EXISTING	STANDARD DUTY ASPHALT PAVING
CURB & GUTTER			HEAVY DUTY ASPHALT PAVING
EASEMENT			HEAVY DUTY CONCRETE PAVING
BUILDING			CONCRETE SIDEWALK
RETAINING WALL			6" STABILIZED D.G.
ADA ACCESSIBLE ROUTE			
WETLAND LIMITS			
TREELINE			
SAWCUT LINE			
SIGN			
PIPE BOLLARD			
NUMBER OF PARKING STALLS PER ROW			
KEY NOTE			

KEY NOTES	
A.	BUILDING, STOOPS, STAIRS (REF. ARCHITECTURAL PLANS )
B.	6" VERTICAL CURB AND GUTTER (M.A.G. STD. DTL. 220-1, TYPE 'A')
C.	6" SINGLE CURB (M.A.G. STD. DTL. 222, TYPE 'A')
D.	BICYCLE PARKING
E.	SIDEWALK RAMP
F.	CONCRETE BOLLARD
G.	CATCH BASIN
H.	CONCRETE SIDEWALK (M.A.G. STD. DTL. 230)
I.	ADA ACCESSIBLE PARKING & STRIPING (T.O.G. STD. DTL. GIL-232)
J.	INTEGRAL SIDEWALK & CURB
K.	DRIVEWAY WITH CURB RETURNS (T.O.G. FIG 4-21)
L.	RIGHT TURN LANE
M.	VALLEY GUTTER (M.A.G. STD. DTL. 240)
N.	CURB TERMINATION (M.A.G. STD. DTL. 222)
O.	LIGHT POLE (REF. PHOTOMETRIC PLAN)
P.	CONCRETE SCUPPER WITH RIPRAP (M.A.G. STD. DTL. 206-1)
Q.	PROPOSED TRASH RECEPTACLE, SEE ARCHITECTURAL PLANS

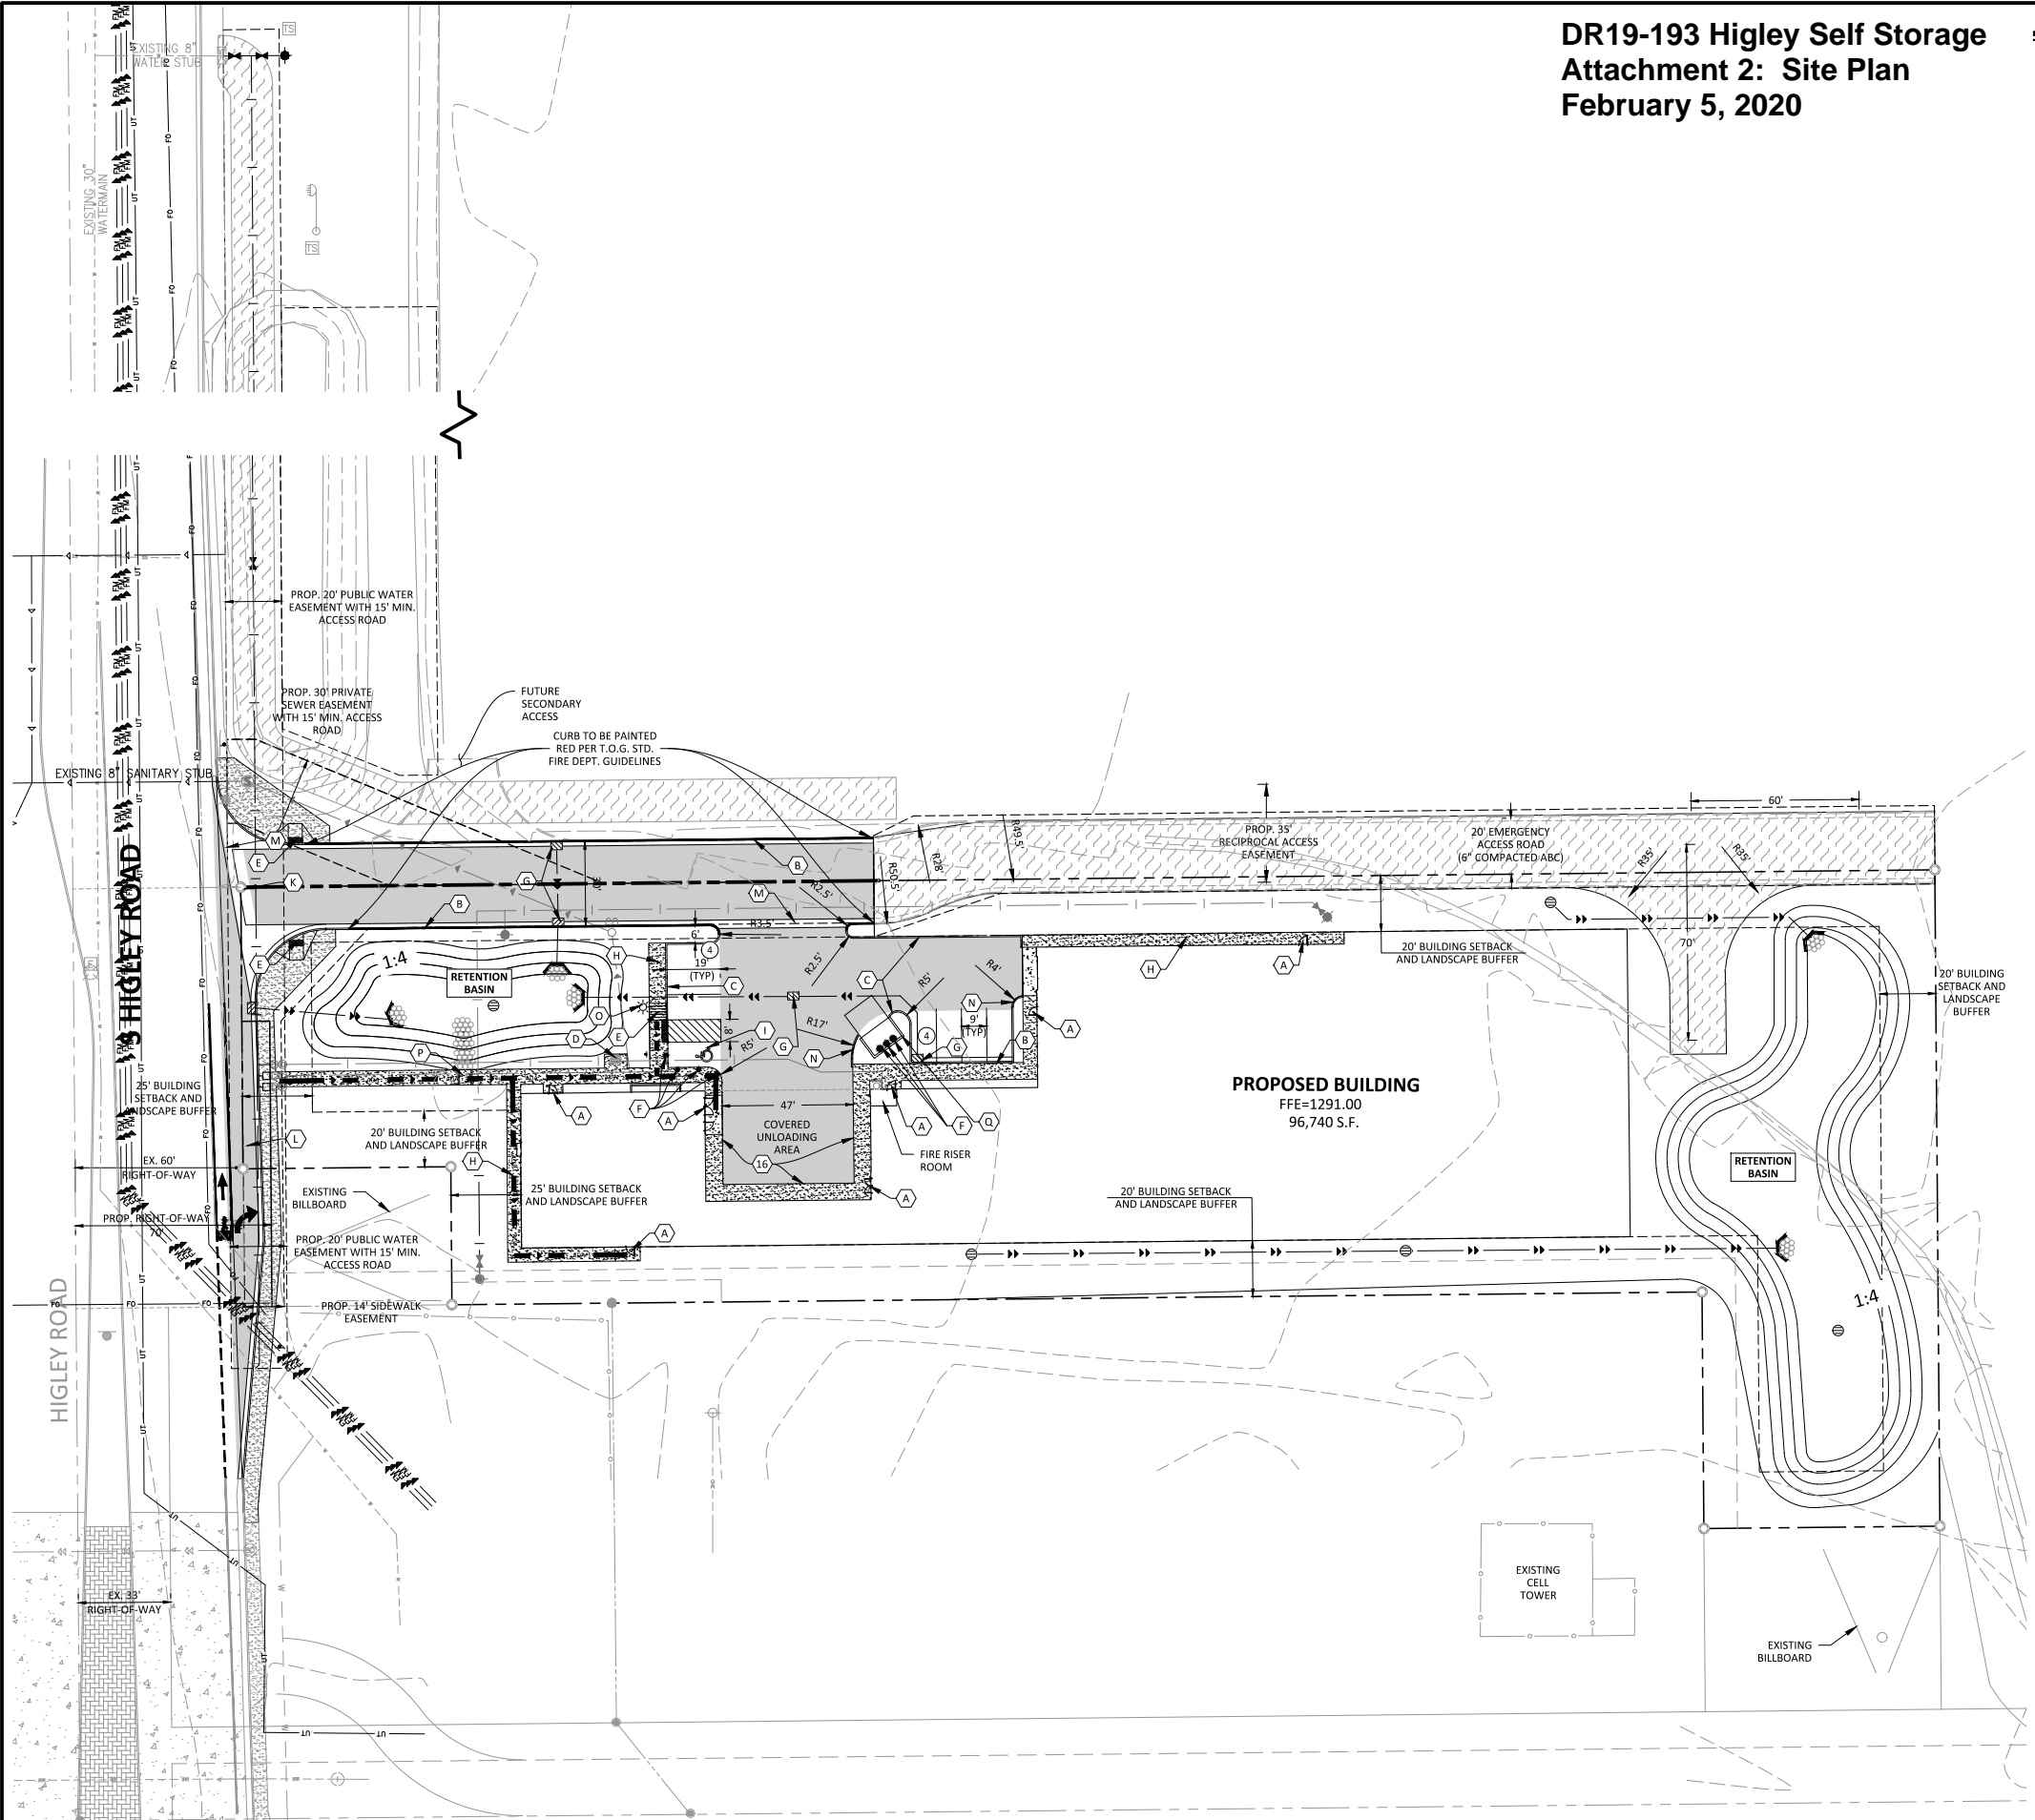


THE SUBSURFACE UTILITY INFORMATION SHOWN ON THESE PLANS IS A UTILITY QUALITY LEVEL. THIS QUALITY LEVEL WAS DETERMINED ACCORDING TO THE GUIDELINES OF ASCE/CES 38-02, TITLED "STANDARD GUIDELINES FOR THE COLLECTION AND DEPICTION OF EXISTING SUBSURFACE UTILITY DATA". THE CONTRACTOR AND/OR SUBCONTRACTORS SHALL DETERMINE THE EXACT LOCATION OF ALL EXISTING UTILITIES BEFORE COMMENCING WORK, BY CONTACTING THE NOTIFICATION CENTER (GOPHER STATE ONE FOR MINNESOTA). THE CONTRACTOR AND/OR SUBCONTRACTOR AGREE TO BE FULLY RESPONSIBLE FOR ANY AND ALL DAMAGES, WHICH MIGHT BE OCCASIONED BY HIS OR HER FAILURE TO EXACTLY LOCATE AND PRESERVE ANY AND ALL UTILITIES (UNDERGROUND AND OVERHEAD).

IF THE CONTRACTOR ENCOUNTERS ANY DRAIN TILE WITHIN THE SITE, HE OR SHE SHALL NOTIFY THE ENGINEER WITH THE LOCATION, SIZE, INVERT AND IF THE TILE LINE IS ACTIVE. NO DRAIN TILE SHALL BE BACKFILLED WITHOUT APPROVAL FROM THE PROJECT ENGINEER.

IT SHALL BE THE RESPONSIBILITY OF THE CONTRACTOR TO RELOCATE ALL EXISTING UTILITIES WHICH CONFLICT WITH THE PROPOSED IMPROVEMENTS SHOWN ON THE PLANS.

Jan 20, 2020 - 5:38pm - User:mgulff L:\PROJECTS\21812\CAD\Civil\Sheets\on-site improvement plan\21812 CS SITE.dwg

LOOP 202 - SANTAN FREEWAY  
SR 202

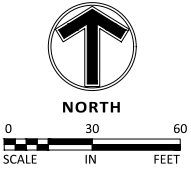

Engineering | Surveying | Planning | Environmental

Client  
**ABERNATHY HOLDING CO.**

222 BROADWAY N., SUITE B101  
FARGO, ND 581-2

Project  
**SOUTH HIGLEY ROAD  
SELF-STORAGE  
IMPROVEMENT  
PLAN**

Location  
**GILBERT, AZ**

1161 S. HIGLEY RD 85296

Certification


Summary  
Designed: AKF Drawn: AKF  
Approved: MJC Book / Page:  
Phase: CD Initial Issued: 12/06/2019

Revision History  
No. Date By Submittal / Revision

Sheet Title  
**SITE PLAN**

Sheet No. Revision  
**C3.0**  
Project No. 21812

DR19-193 Higley Self Storage  
Attachment 3: Landscape  
February 5, 2020

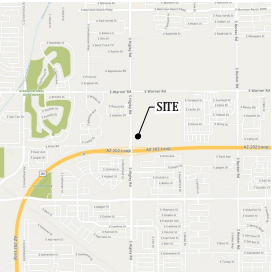

VICINITY MAP  
NO SCALE

PLANT SCHEDULE

TREES	CODE	BOTANICAL / COMMON NAME	CONT	CAL	SIZE	QTY
	DW	Chilopsis linearis / Desert Willow	Cont.	24"		7
	DAL SIS	Dalbergia sissoo / Rosewood	Cont.	24"		5
	FO	Olea europaea 'Fruitless' / Fruitless Olive	Cont.	24"		8
	CP	Pistacia chinensis / Chinese Pistache	Cont.	24"		6
	CM	Prosopis chilensis / Chilean Mesquite	Cont.	Clump	24"	10
	YB	Tecoma stans / Yellow Bells	Cont.		24"	27
	TT	Tipuana tipu / Tipu Tree	Cont.		24"	2
	VAC	Vitex agnus-castus / Chaste Tree	Cont.	24"		12
	CT	x Chitalpa tashkentensis / Chitalpa	Cont.		24"	9
SHRUBS	CODE	BOTANICAL / COMMON NAME	CONT			QTY
	SS	Calliandra x 'Maricopa Red' TM	5 gal.			10
	BB	Eremophila hygrophana / Emu Bush (Blue Bells)	5 gal.			25
	MH	Justicia spicigera / Mohintli Mexican Honeysuckle	5 gal.			19
	BS	Leucophyllum langmaniae 'Rio Bravo' TM / Rio Bravo Langman's Sage	5 gal.			32
	NO	Nerium oleander 'Petite Pink' / Petite Pink Oleander	5 gal.			37
	PR	Ruellia brittoniana 'Purple Showers' / Sterile Mexican Petunia	5 gal.			18

TOWN OF GILBERT LANDSCAPE CODE

CITY OF GILBERT, AZ LANDSCAPE STANDARDS:

SIDE AND REAR PERIMETER LANDSCAPING REQUIREMENTS: PERIMETER AREA = 28,200  
EVERGREEN TREES 3/1000SF 85 TREES  
SHRUBS 5/1000SF 141 SHRUBS  
VEGETATIVE GROUNDCOVER 20% OF AREA 5,600 SF  
INORGANIC GROUNDCOVER 100% OF AREA

PARKING LOT SCREENING NOT APPLICABLE AS PARKING IS OVER 75' FROM R.O.W.  
PARKING LOT TREES REQUIRED 1 TREE FOR EVERY 8 STALLS = 1

PLANT TYPE	REQUIRED	PROVIDED
EVERGREEN TREES	86	86
SHRUBS	141	141

TOP DRESSING (ENTIRE SITE)  
1/2" SCREENED - DECOMPOSED GRANITE - EXPRESS BROWN COLOR TO BE APPLIED TO ALL LANDSCAPE AREAS INCLUDING LANDSCAPE MEDIANS

IRRIGATION:  
ALL PLANTINGS TO BE IRRIGATED USING EFFICIENT DRIP IRRIGATION SYSTEM  
USE OF THE WATER EFFICIENT TECHNOLOGY INCENTIVE (WETI) PROGRAM THROUGH THE CITY OF GILBERT IS HIGHLY RECOMMENDED

LEGEND

	PROPOSED	EXISTING
PROPERTY LIMIT		
CURB & GUTTER		
EASEMENT		
BUILDING		
RETAINING WALL		
WETLAND LIMITS		
TREELINE		
LANDSCAPE EDGING		
SIGN		
PIPE BOLLARD		
SAWCUT LINE		
LANDSCAPE LIGHT		



0 30 60  
SCALE IN FEET

Engineering | Surveying | Planning | Environmental

Client

ABERNATHY  
HOLDING CO.

222 BROADWAY N., SUITE B101  
FARGO, ND 581-2

Project

SOUTH HIGLEY  
ROAD  
SELF-STORAGE  
IMPROVEMENT  
PLAN

Location

GILBERT, AZ

1161 S. HIGLEY RD 85296

Certification

Summary

Designed: AKF Drawn: AKF  
Approved: MJC Book / Page:  
Phase: CD Initial Issued: 12/06/2019

Revision History

No. Date By Submittal / Revision


Sheet Title  
LANDSCAPE  
PLAN

Sheet No. Revision

L1.0

Project No. 21812



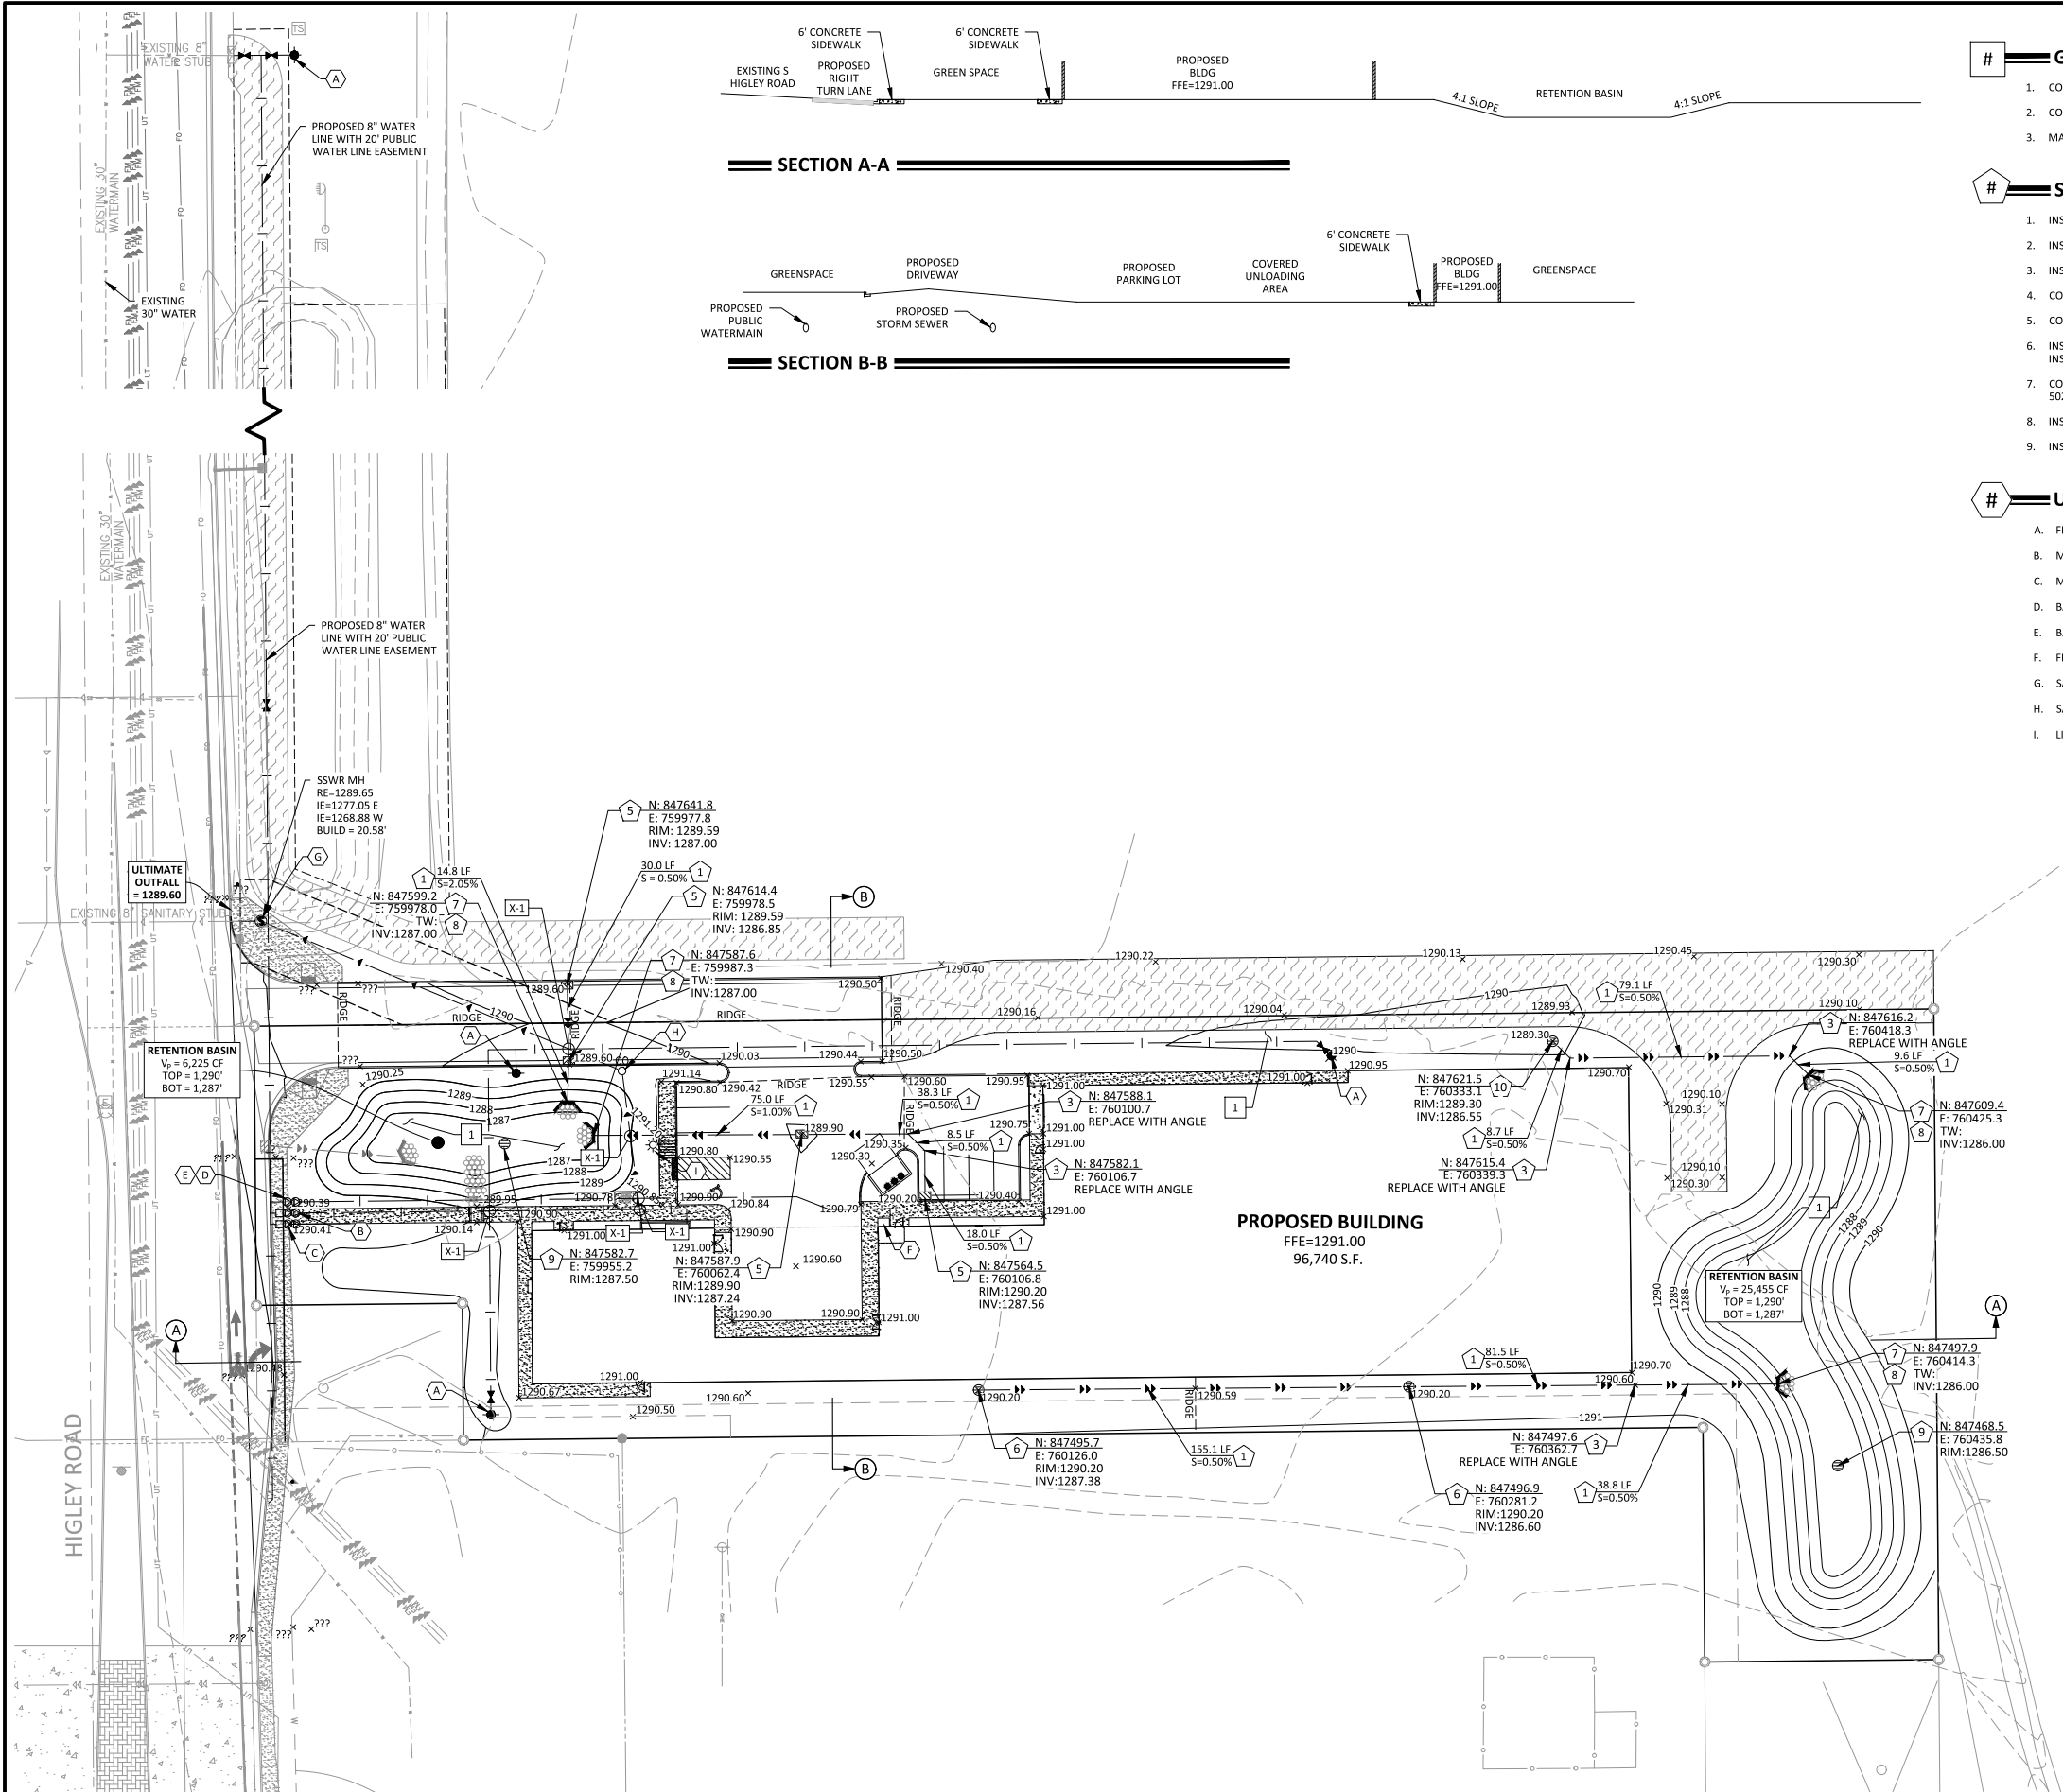

THE SUBSURFACE UTILITY INFORMATION SHOWN ON THESE PLANS IS A UTILITY QUALITY LEVEL 1. THIS QUALITY LEVEL WAS DETERMINED ACCORDING TO THE GUIDELINES OF ASCE/CES 38-02, TITLED "STANDARD GUIDELINES FOR THE COLLECTION AND DEPICTION OF EXISTING SUBSURFACE UTILITY DATA". THE CONTRACTOR AND/OR SUBCONTRACTORS SHALL DETERMINE THE EXACT LOCATION OF ALL EXISTING UTILITIES BEFORE COMMENCING WORK, BY CONTACTING THE NOTIFICATION CENTER (GOPHER STATE ONE FOR MINNESOTA). THE CONTRACTOR AND/OR SUBCONTRACTOR AGREE TO BE FULLY RESPONSIBLE FOR ANY AND ALL DAMAGES, WHICH MIGHT BE OCCASIONED BY HIS OR HER FAILURE TO EXACTLY LOCATE AND PRESERVE ANY AND ALL UTILITIES (UNDERGROUND AND OVERHEAD).

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Jun 20, 2020 - 5:23pm - User:mguff L:\PROJECTS\1812\CAD\Civil\Sheets\grd\site improvement plan\21812 CS-GRADG.dwg

## # GRADING NOTES

1. CONSTRUCT RETENTION BASIN PER CONTOURS SHOWN.
2. CONSTRUCT SWALE.
3. MATCH EXISTING ELEVATIONS.

## # STORM DRAIN NOTES

1. INSTALL 12" H.D.P.E. STORM DRAIN PIPE. LENGTH & SLOPE PER PLAN.
2. INSTALL 18" H.D.P.E. STORM DRAIN PIPE. LENGTH & SLOPE PER PLAN.
3. INSTALL BEND. ANGLE PER PLAN. SIZE PER ADJOINING PIPE DIAMETER.
4. CONSTRUCT CATCH BASIN PER M.A.G. STD. DTL. 535.
5. CONSTRUCT CATCH BASIN, TYPE 'E', PER M.A.G. STD. DTL. 534.
6. INSTALL INLINE DRAIN (TEE OR 90") PER DETAIL ON SHEET C7.0. TEE SIZE PER ADJOINING PIPE DIAMETER. INSTALL 12" ADS STANDARD RATED GRATE OR APPROVED EQUAL.
7. CONSTRUCT 'U' TYPE HEADWALL PER M.A.G. STD. DTL. 501-1 WITH TRASH RACK PER M.A.G. STD. DTL. 502-2. CONTRACTOR TO FIELD GRADE AROUND HEADWALL FOR PROPER DRAINAGE IF NECESSARY.
8. INSTALL LOOSE RIP-RAP,  $D_{50} = X"$ ,  $X"$  DEEP...
9. INSTALL MAXWELL IV DRYWELL PER DETAIL ON SHEET C7.0.

## # UTILITY NOTES

- A. FIRE HYDRANT (T.O.G. STD. DTL. GIL-320-2)
- B. METER AND BACKFLOW (DOMESTIC)
- C. METER AND BACKFLOW (IRRIGATION)
- D. BACKFLOW (FIRE SPRINKLER)
- E. BACKFLOW (FIRE HYDRANT LINE)
- F. FIRE DEPARTMENT CONNECTION
- G. SANITARY SEWER MANHOLE (M.A.G. STD. DTL. 420-1)
- H. SANITARY SEWER CLEANOUT (M.A.G. STD. DTL. 441)
- I. LIGHT POLE (REF. PHOTOMETRIC PLAN)

## Client

## ABERNATHY HOLDING CO.

222 BROADWAY N., SUITE B101  
FARGO, ND 581-2

## Project

## SOUTH HIGLEY ROAD SELF-STORAGE IMPROVEMENT PLAN

## Location

## GILBERT, AZ

1161 S. HIGLEY RD 85296

## Certification

## Summary

Designed: AKF Drawn: AKF  
Approved: MJC Book / Page:  
Phase: CD Initial Issued: 12/06/2019

## Revision History

No. Date By Submittal / Revision



## Sheet Title GRADING & DRAINAGE PLAN

## Sheet No. Revision

## C5.0

## Project No. 21812


NOT FOR CONSTRUCTION

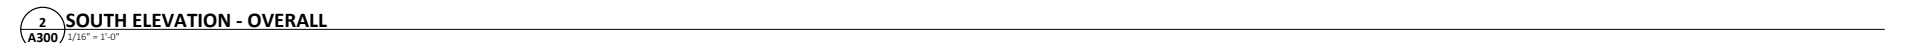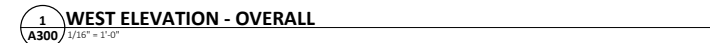

Technical drawing of a loading container with dimensions and callouts:

- 6" DI. PIPE BOLLARD CONCRETE FILLED, SET IN CONCRETE 3'-0" BELOW GRADE, EXTEND 4'-0" ABOVE GRADE, PAINT OSHA YELLOW
- 12'-0" INSIDE CLEAR
- LOADING CONTAINER
- 3'-0" 3'-0" 3'-0" 3'-0"
- 8" DIA. STEEL POST - PAINTED
- 3/4" DIA. BY 1 1/2" DEEP RECESSES FOR GATE CAME BOLTS. PROVIDE TWO EACH AT OPEN POSITION, FIELD VERIFY EXACT LOCATION
- 8" CMU W/ BRICK TO MATCH BUILDING EXTERIOR.
- 6" DIA. BOLLARD - PAINTED
- SLOPE CONCRETE PAD TO FRONT 1/8" PER FT. - SEE SITE PLAN FOR CONTROLS.
- 120/000

NOTE: VERIFY PLAN W/ SANITATION COURIER PRIOR TO CONSTRUCTION.

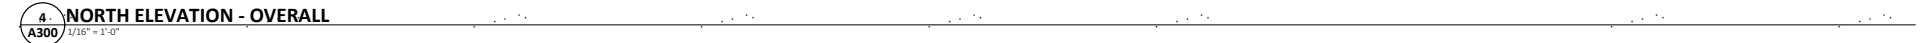

**EIFS-1: AMARILLO WHITE EIFS**




**EIFS-2: TOASTED ALMOND EIFS**







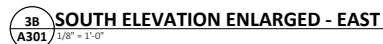

## EXTERIOR MATERIALS LEGEND

<b>(EPS)-1</b>	EXTERIOR INSULATION AND FINISH SYSTEM - DRYVIT OUTSULATION COLOR: AMARILLO WHITE TEXTURE: SANDPEBBLE FINE-NTX
<b>(EPS)-2</b>	EXTERIOR INSULATION AND FINISH SYSTEM - DRYVIT OUTSULATION COLOR: GRAY STEEL TEXTURE: SANDPEBBLE FINE-NTX
<b>(BRK)-1</b>	MODULAR TUFF BRICK - METROBRICK COLOR: SCHOOHOUSE RED
<b>(MTL)-1</b>	PREFINISHED METAL TRIM COLOR: ALUMINUM
<b>(MTL)-2</b>	PREFINISHED METAL TRIM COLOR: MATCHING MTL-1 (CITYSCAPE)
<b>(MTL)-3</b>	ACM PANEL COLOR: RYENBOND DURAGLOSS 5000 ZINC PATINA
<b>(MTL)-4</b>	7.2 PROFILE METAL PANEL COLOR: LIGHT GREY COLOR TO MATCH SHERWIN WILLIAMS ARGOS
<b>(MTL)-5</b>	ACM PANEL & PREFINISHED METAL TRIM COLOR: DARK GREY TO MATCH SHERWIN WILLIAMS IRON ORE (P-1)
<b>(P)-1</b>	EXTERIOR PAINT COLOR: SHERWIN WILLIAMS IRON ORE



**GREAT STATES**  
CONSTRUCTION

**SOUTH HIGLEY ROAD  
SELF-STORAGE  
NEW CONSTRUCTION**

13244 S. HIGLEY RD  
GILBERT, AZ 85296

DOO HEAT NAME

**ABSTRACT**



THE ARCHITECT SHALL BE DEEMED THE AUTHORS AND OWNERS OF THEIR RESPECTIVE INSTRUMENTS OF SERVICE AND SHALL RETAIN ALL COMMON LAW, STATUTORY AND OTHER RESERVED RIGHTS, INCLUDING COPYRIGHTS OF THE ATTACHED DOCUMENTS.

[illegible]

**DRAWING INFORMATION**

PROJECT NUMBER: 19160-0ABR

DRAWN BY: N. MISSING

CHECKED BY: S. OLIVER

DATE: 12-30-2019

COMPUTER DIRECTORY:

Path

**ENLARGED  
EXTERIOR  
ELEVATIONS -  
WEST AND SOUTH**



PHASE	PERMIT DOCUMENTS
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A301



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**DR19-193 Higley Self Storage  
Attachment 6: Elevations  
February 5, 2020**



## EXTERIOR MATERIALS LEGEND

<b>(EPS)-1</b>	EXTERIOR INSULATION AND FINISH SYSTEM - DRYVIT OUTSULATION COLOR: AMARILLO WHITE TEXTURE: SANDPEBBLE FINE-NTX
<b>(EPS)-2</b>	EXTERIOR INSULATION AND FINISH SYSTEM - DRYVIT OUTSULATION COLOR: GRAY STEEL TEXTURE: SANDPEBBLE FINE-NTX
<b>(BRK)-1</b>	MODULAR THIN BRICK - METROBRICK COLOR: SCHOOLHOUSE RED
<b>(MTL)-1</b>	PREFINISHED METAL TRIM COLOR: ALMOND
<b>(MTL)-2</b>	PREFINISHED METAL TRIM COLOR: MATCHING MTL-3 (CITYSCAPE)
<b>(MTL)-3</b>	ACM PANEL COLOR: REYNOLD BUND DURAGLOSS 5000 ZINC PATINA
<b>(MTL)-4</b>	7.7 PROFILE METAL TRIM COLOR: LIGHT GREY COLOR TO MATCH SHERWIN WILLIAMS ARGOS
<b>(MTL)-5</b>	ACM PANEL & PREFINISHED METAL TRIM COLOR: DARK GREY TO MATCH SHERWIN WILLIAMS IRON ORE (P-1)
<b>(P)-1</b>	EXTERIOR PAINT COLOR: SHERWIN WILLIAMS IRON ORE

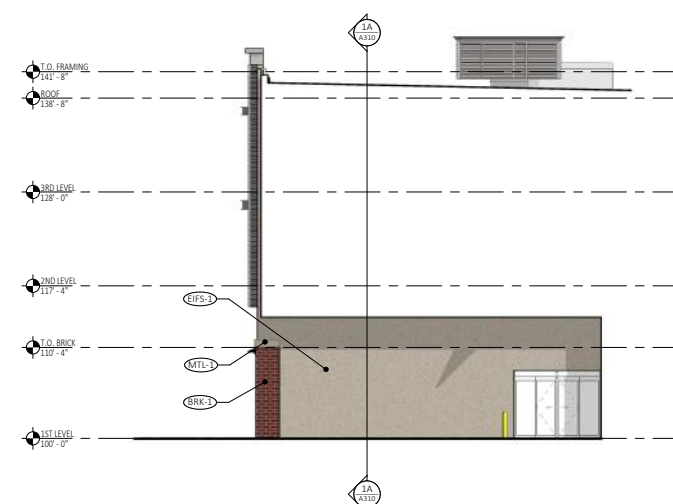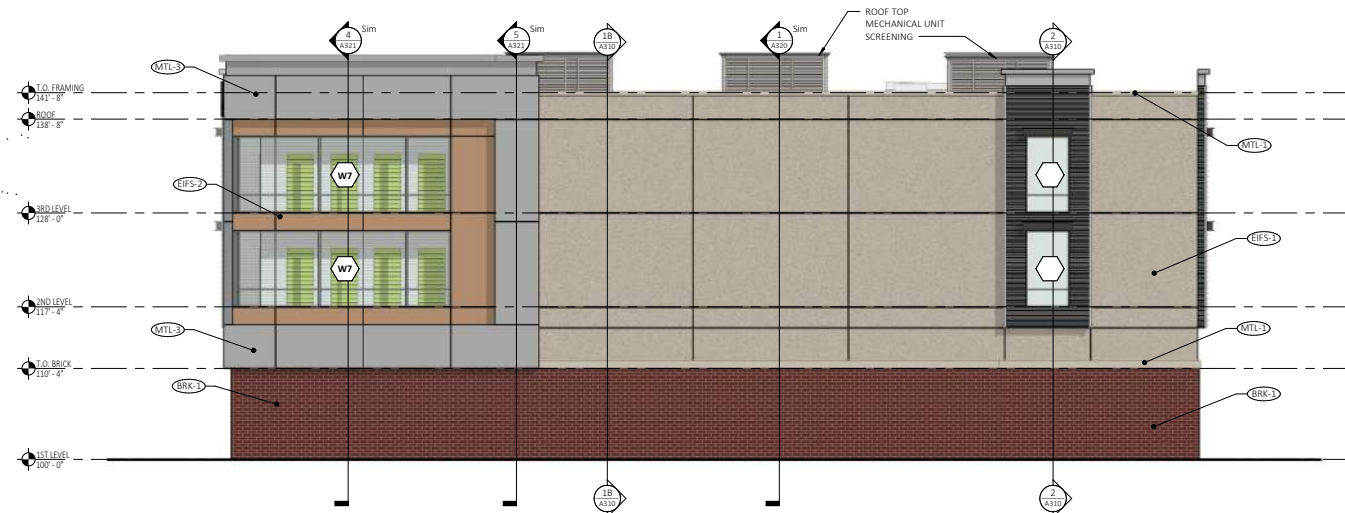

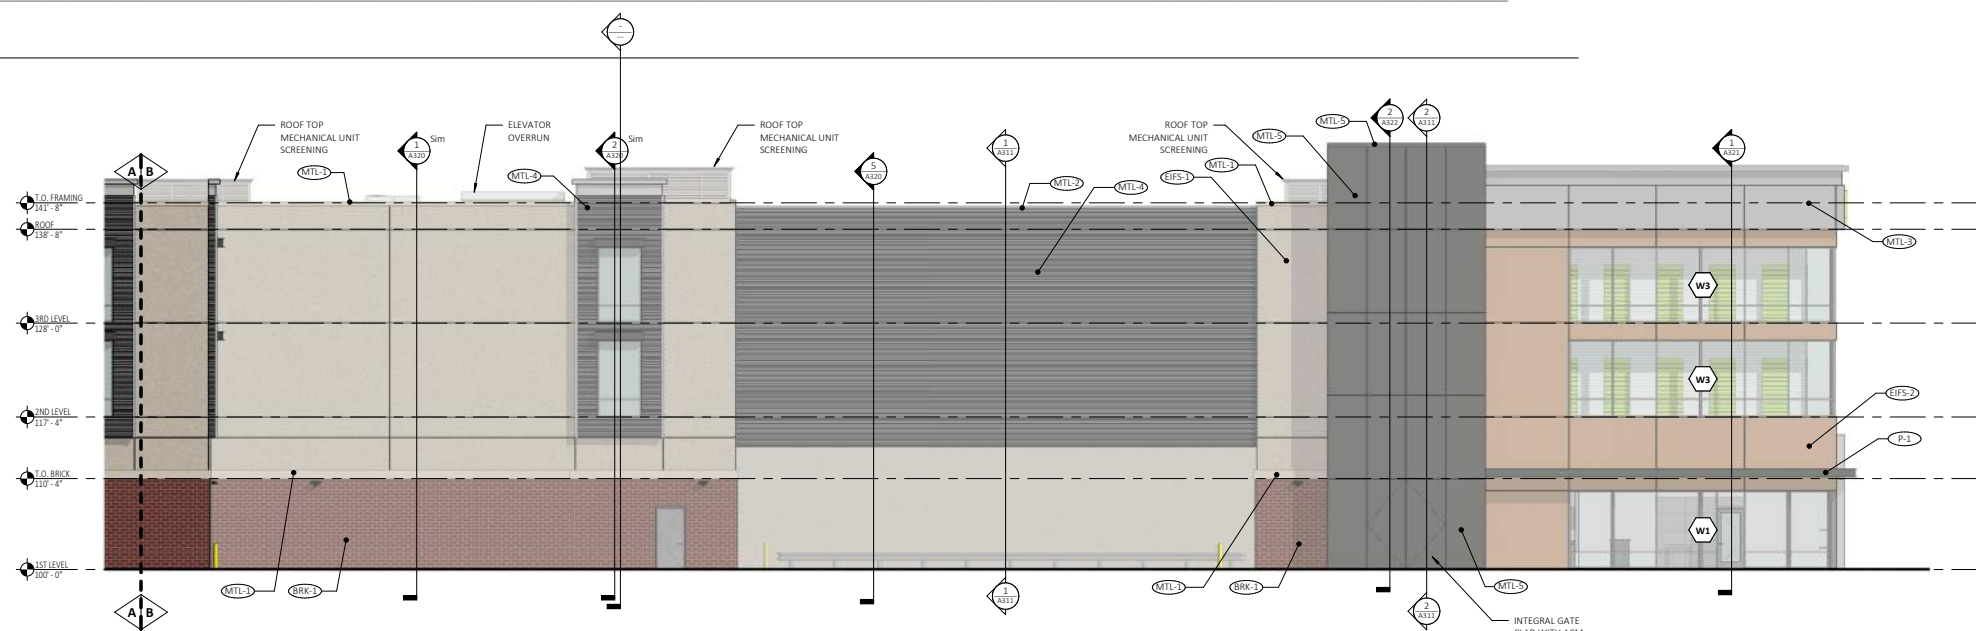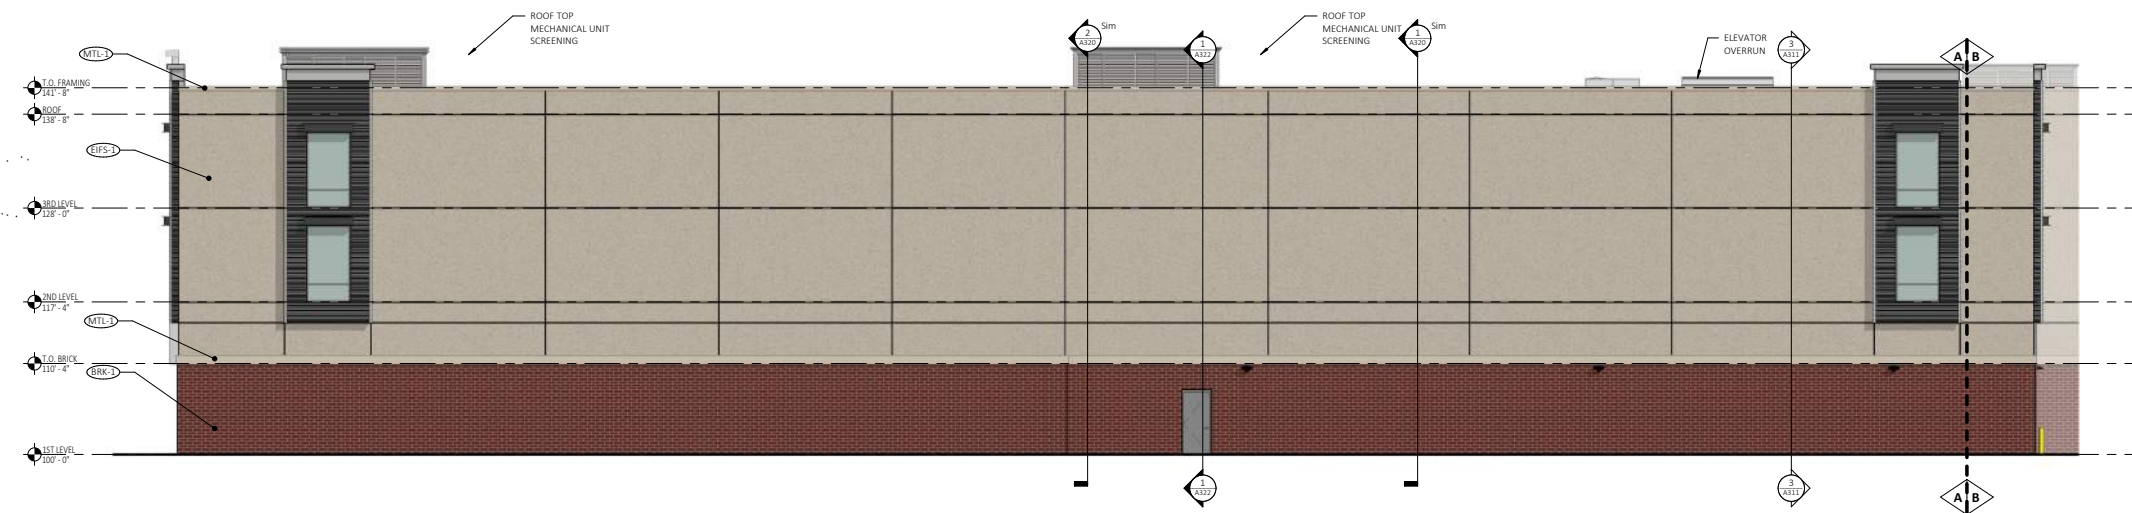

**1 1ST LEVEL - FLOOR PLAN OVERALL**  
**A200** 1/16" = 1'-0"

**2ND LEVEL - FLOOR PLAN OVERALL**  
A200 1/16" = 1'-0"

3 3RD LEVEL - FLOOR PLAN OVERALL

UNIT MIX - OVERALL W/ S.F.				
UNIT SIZE	COUNT	Unit Type Percentage	UNIT CLASS S.F.	UNIT CLASS TOTAL AREA
5x5	81	11.6%	25	2025
5x10	146	20.9%	50	7300
5x15	95	13.6%	75	7125
7x5x10	12	1.7%	75	900
10x10	176	25.2%	100	17510
10x15	116	16.6%	150	17400
10x20	37	5.3%	200	7400
10x25	10	1.4%	250	2500
10x30	26	3.7%	300	7800
Grand total	699			69960

UNIT MIX - 1ST LEVEL W/ S.F.				
UNIT SIZE	COUNT	Unit Type Percentage	UNIT CLASS S.F.	UNIT CLASS TOTAL A.C.
5x5	6	3.6%	25	150
5x10	27	16.0%	50	1350
5x15	11	6.5%	75	825
7.5x10	8	4.7%	75	600
10x10	48	28.4%	100	4800
10x15	30	17.8%	150	4500
10x20	20	11.8%	200	4000
10x25	2	1.2%	250	500
10x30	17	10.1%	300	5100
Grand total	169			21825

UNIT MIX - 2ND LEVEL W/ S.F.				
UNIT SIZE	COUNT	Unit Type Percentage	UNIT CLASS S.F.	UNIT CLASS TOTAL A/R
5x5	26	11.3%	25	650
5x10	37	16.1%	50	1850
5x15	32	13.9%	75	2400
7.5x10	4	1.7%	75	300
10x10	65	28.3%	100	6400
10x15	32	13.9%	150	4800
10x20	17	7.4%	200	3400
10x25	8	3.5%	250	2000
10x30	9	3.9%	300	2700
Grand total	230			24510

UNIT MIX - 3RD LEVEL W/ S.F.				
UNIT SIZE	COUNT	Unit Type Percentage	UNIT CLASS S.F.	UNIT CLASS TOTAL AREA
5x5	49	16.3%	25	1225
5x10	82	27.3%	50	4100
5x15	52	17.3%	75	3900
10x10	63	21.0%	100	6300
10x15	54	18.0%	150	8100
Grand total	300			23625



## GENERAL ROOF NOTES

1. COORDINATE RTU LOCATIONS WITH MECHANICAL DRAWINGS.
2. SEAL ALL ROOF PENETRATIONS W/ CHLORIDE FREE SPRAY FOAM FOR VAPOR AND AIR CONTROL. ALL FOAM SHALL BE PENUM RATED OR EQUIVALENT WITH PENUM RATED MATERIALS (FIRE STOPPING OR SHEET METAL). FULLY ENCASE VAPOR BARRIER AT ALL PENETRATIONS.
3. TAPERED INSULATION INSTALLED AT CRICKETS TO BE 1/2" SLOPE. ROOFING CONTRACTOR TO VERIFY CRICKET LOCATIONS. (1/2" TAPERED OVER 1/4" PER FOOT ROOF SLOPE RESULTS IN 3/8" SLOPE)
4. ROOF MUST MAINTAIN A MINIMUM OF 1/4" PER FOOT SLOPE.
5. ROOFING MEMBRANE TO BE INSTALLED PER MANUFACTURER RECOMMENDED MATERIALS.
6. PROVIDE ROOF SYSTEM CONTROL JOINTS AS RECOMMENDED BY SYSTEM MFG.

## ROOF ASSEMBLY

- FULLY ADHERED TPO ROOF MEMBRANE
- 2" RIGID INSULATION (LAYER 1 = R11.4)
- 2" RIGID INSULATION (LAYER 2 = R11.4) (STAGGER JOINTS FROM LAYER 1)
- METAL DECKING (SEE STRUCTURAL)

NOTE: PROVIDE ALTERNATE PRICING FOR A MECHANICALLY FASTENED ROOF ASSEMBLY WITH A 10 MIL VAPOR BARRIER ADHERED TO THE DECK.

## ROOF PLAN KEYNOTES

TAG	KEYNOTE
1	SCUPPER/OVERFLOW TO DOWNSPOUT
2	COORDINATE OUTLET WITH CIVIL - AVOID SURFACE DRAINAGE OVER SIDEWALK.
3	1/2" P/2" FLOP TAPERED INSULATION CRICKET, RESULTING IN 3/8" PER FOOT NET SLOPE OVER SLOPED STRUCTURE.
4	ENVISOR 3 SCREENING SYSTEM (SEE MECH. NOTE 6 ON A000 COVER SHEET)
5	ROOF HATCH: BULCO L-50TB (30x96") WITH INTEGRAL FALL PROTECTION RAILING AND GATE
6	ELEVATOR OVERRUN; EXTEND ROOF SYSTEM AND INSULATION OVER THE CONDITION

[illegible]



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PROJECT NUMBER: 19160\_DABR

DRAWN BY: MSA

CHECKED BY: PE

DATE: 11/01/2019

COMPUTER DIRECTORY:  
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## PHOTOMETRIC SITE PLAN

CITY SUBMITTAL - DESIGN  
REVIEW

## E100

